From:
 Deardoff, Amy

 To:
 Robinson, Kelly

 Cc:
 McWilliams, Katherine

Subject: RE: Re:

**Date:** Monday, March 06, 2017 1:45:00 PM

Attachments: ARG590001 As Built Engineering Plan Sheets 20130412.pdf

I believe this is it. The last page shows the email in the attached Word document.

Amy Deardoff P: 501-682-0650 F: 501-682-0880

From: Robinson, Kelly

Sent: Monday, March 06, 2017 1:41 PM

To: Deardoff, Amy Subject: FW: Re:

Amy,

Do you know if we have the document that Mr Murdoch is requesting.

## **Kelly Robinson**

Public Information Officer 5301 Northshore Drive North Little Rock, AR 72118

501-682-0916

From: John Murdoch [mailto:artzbarn@gmail.com]

Sent: Monday, March 06, 2017 9:37 AM

To: Robinson, Kelly Subject: Re:

Kelly,

Thank you. I have a last request. It was easier to cut and paste to explain from the last link you sent me.

Thank you, John Murdoch

On Mon, Mar 6, 2017 at 9:20 AM, Robinson, Kelly <<u>ROBINSON@adeq.state.ar.us</u>> wrote: Good morning, Mr. Murdoch.

I think this is what you are looking for.

https://www.adeq.state.ar.us/downloads/WebDatabases/PermitsOnline/NPDES/PermitInformation/ARG590001\_AsBuilt Engineering Plan Sheets 20130412.pdf

Trusting all is well with you.

## **Kelly Robinson**

Public Information Officer 5301 Northshore Drive North Little Rock, AR 72118

501-682-0916

From: J. Murdoch [mailto:jfmurdoch3@gmail.com]
Sent: Thursday, March 02, 2017 10:01 AM
To: Robinson, Kelly

Subject:

Kelly,

I was trying to locate the engineering drawings for the "AS BUILT" for the C&H Hog Farms site April 12, 2013. (ARG590001). I had a copy but can not find it on my drive or on the ADEQ website.

Could you send me a link or the file. I have the NOI and NMP file, but I would like to review the "As Built" copy which came out April 2013.

Thank you, John Murdoch

## C & H HOG FARMS GESTATION-FARROWING FARM


## AS BUILT ENGINEERING PLAN SHEETS

SECTION 26, T 15 N, R 20 W NEWTON COUNTY, ARKANSAS

DATE: APRIL 12, 2013

SHEET INDEX

SHEET 7 -WASTE STORAGE POND FINAL DESIGN SHEET 8 -PROPOSED SITE PLAN CROSS SECTION SHEET 10 -WASTE STORAGE POND & BARN CROSS SECTIONS SHEET 11 -WASTE STORAGE POND CROSS SECTIONS SHEET 13 -POND INLET & MAXIMUM BERM DETAILS SHEET 14 -WASTE STORAGE POND 1 STAGE STORAGE TABLE SHFFT 15 -WASTE STORAGE POND 2 STAGE STORAGE TABLE

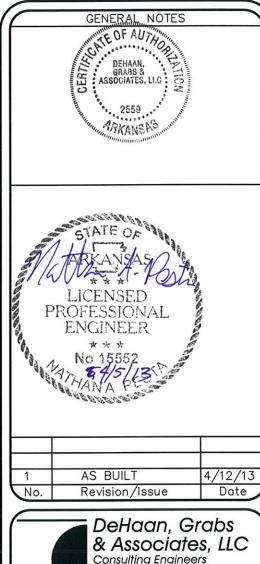





C & H HOG FARMS GESTATION-FARROWING FARM


> SECTION 26, T 15 N, R 20 W NEWTON COUNTY, AR


COVER SHEET

	DATE:	SHEET:
ı	JUN 1, 2012	
	SCALE: NONE	
	DRAWN BY: NAP	COVER
l	CHECKED BY:	

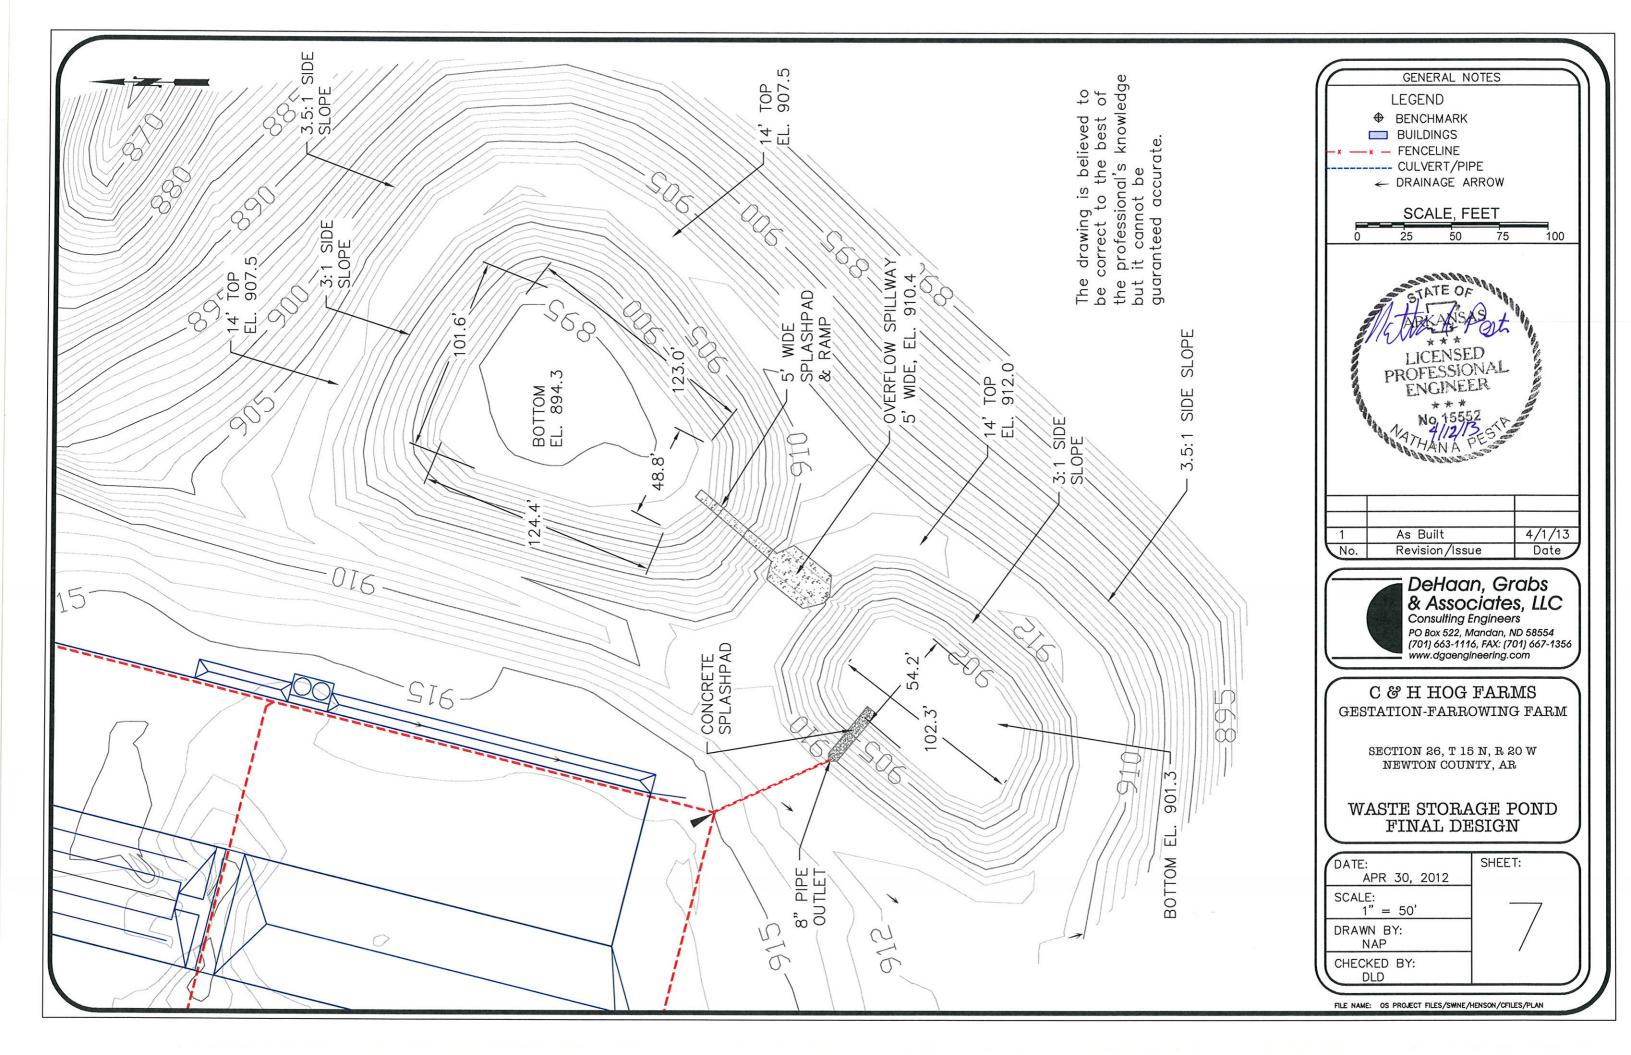

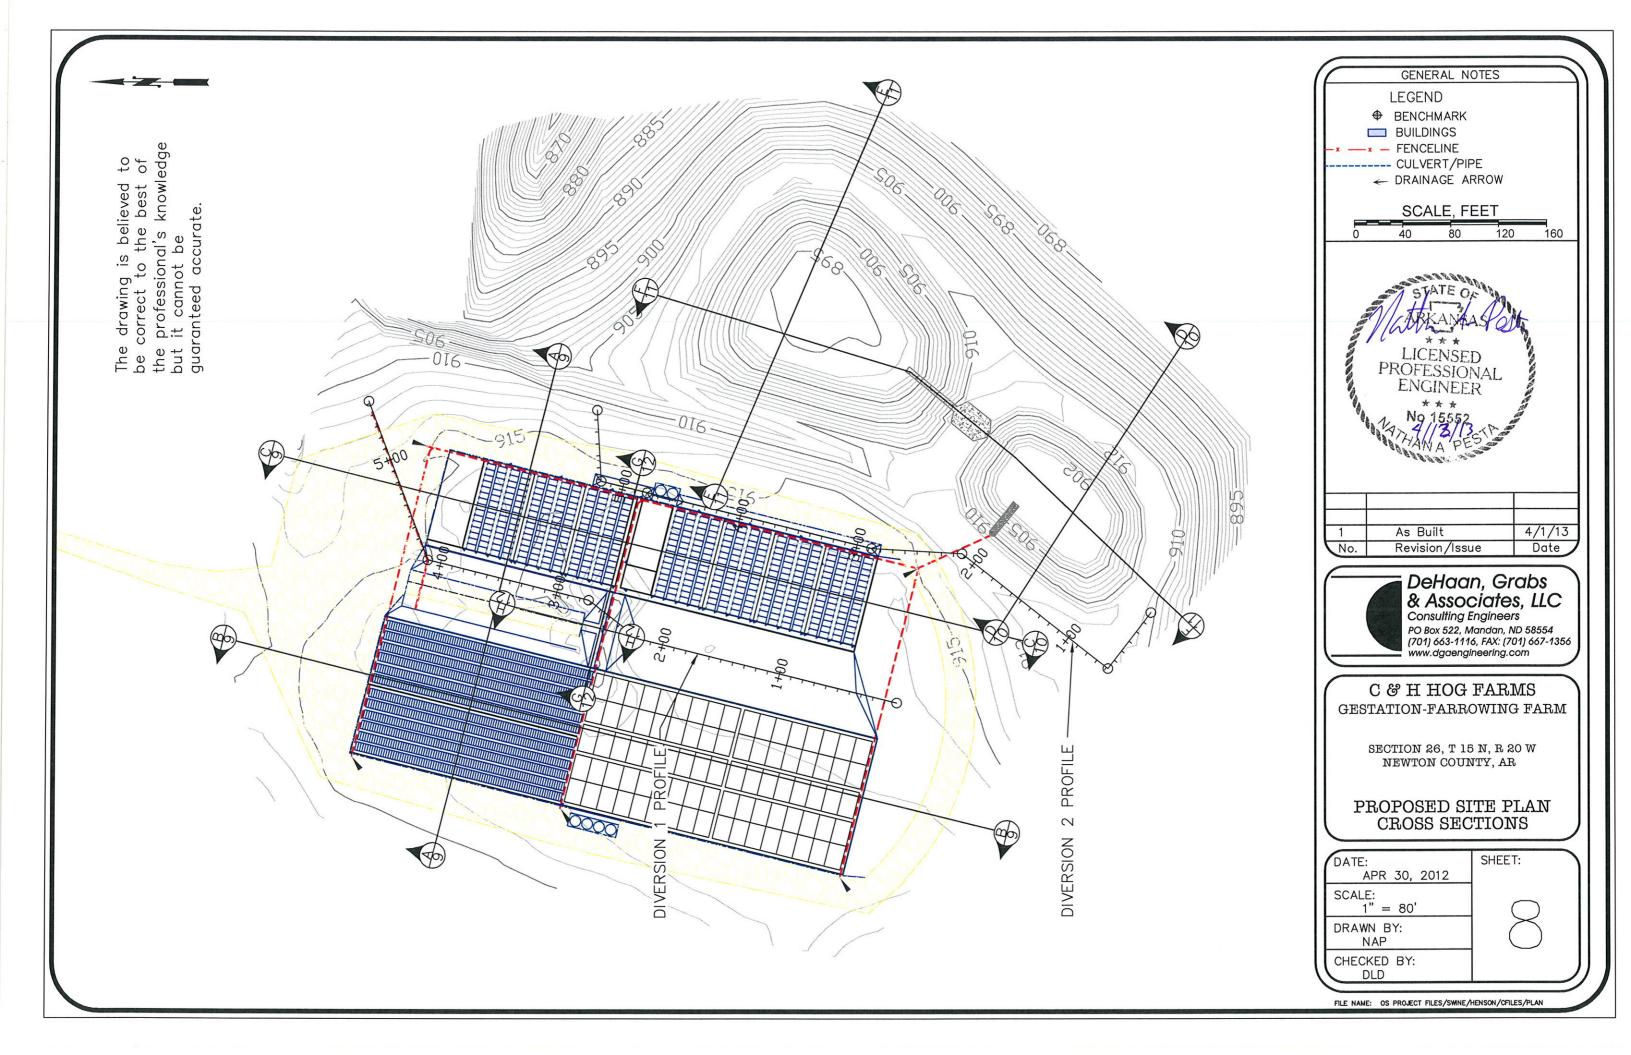

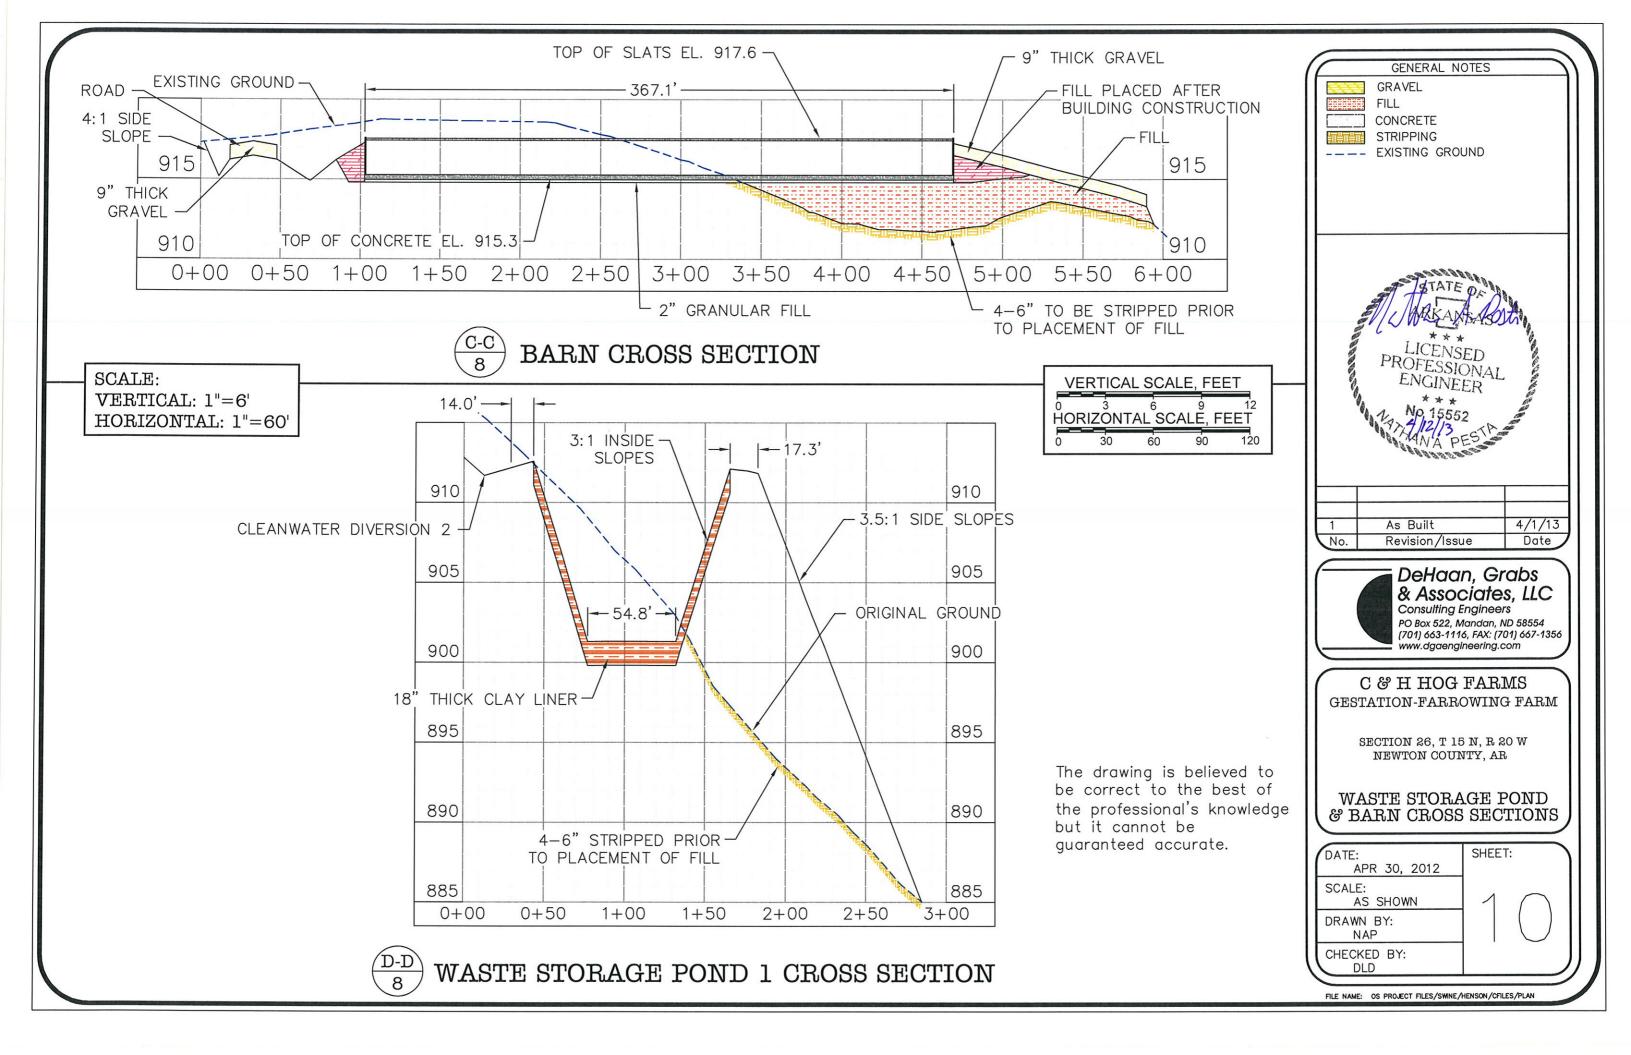

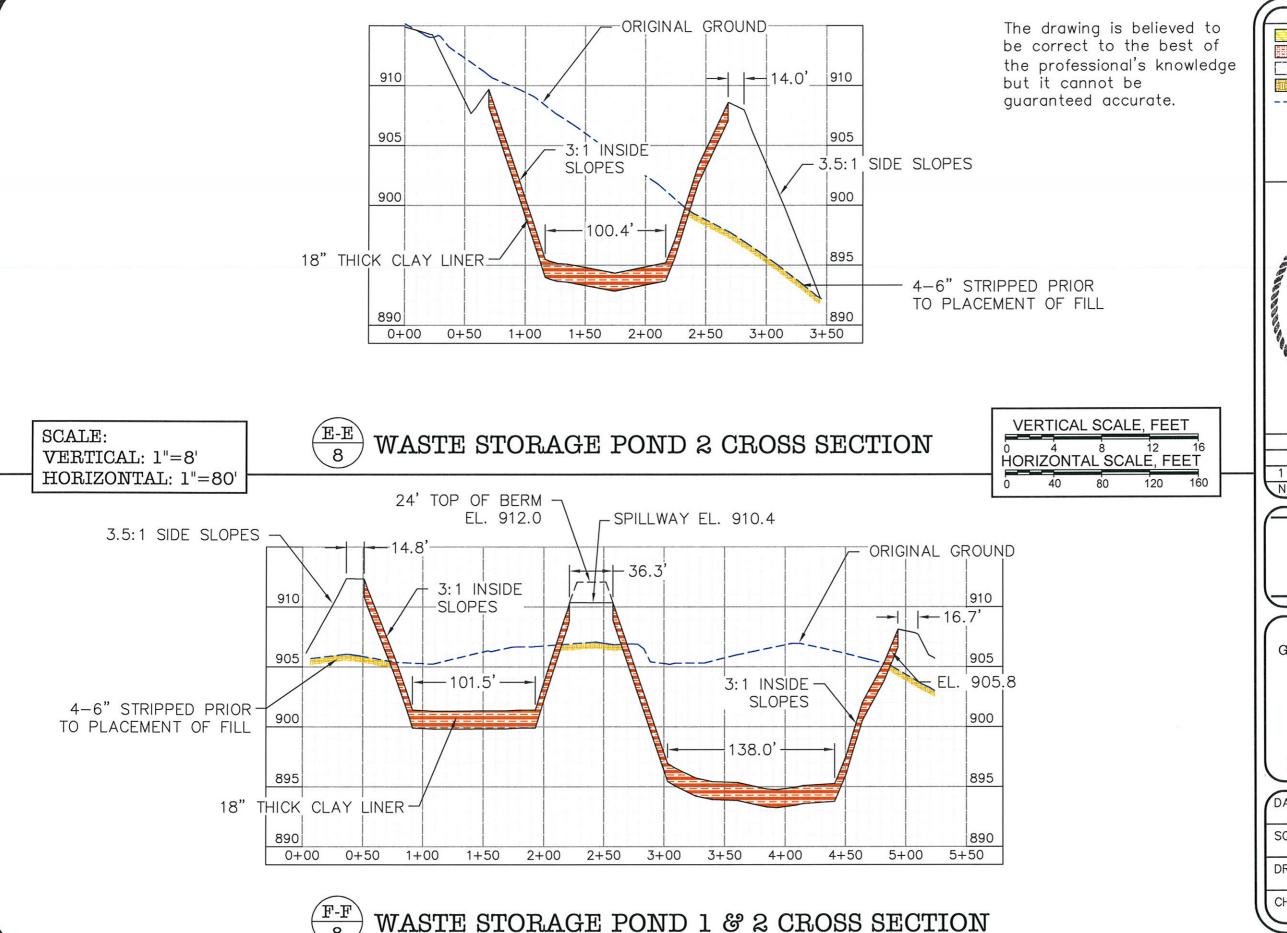

GENERAL NOTES

GRAVEL
FILL
CONCRETE
STRIPPING
---- EXISTING GROUND

LICENSED
PROFESSIONAL
ENGINEER

No 15552
14712/13
No. Revision/Issue Date

8 C P (7 W

DeHaan, Grabs & Associates, LLC Consulting Engineers


Consulting Engineers
PO Box 522, Mandan, ND 58554
(701) 663-1116, FAX: (701) 667-1356
www.dgaengineering.com


C & H HOG FARMS GESTATION-FARROWING FARM

> SECTION 26, T 15 N, R 20 W NEWTON COUNTY, AR


WASTE STORAGE POND CROSS SECTIONS

DATE: APR 30, 2012	SHEET:	•
SCALE: AS SHOWN	] 1 1	
DRAWN BY: NAP		
CHECKED BY: DLD		

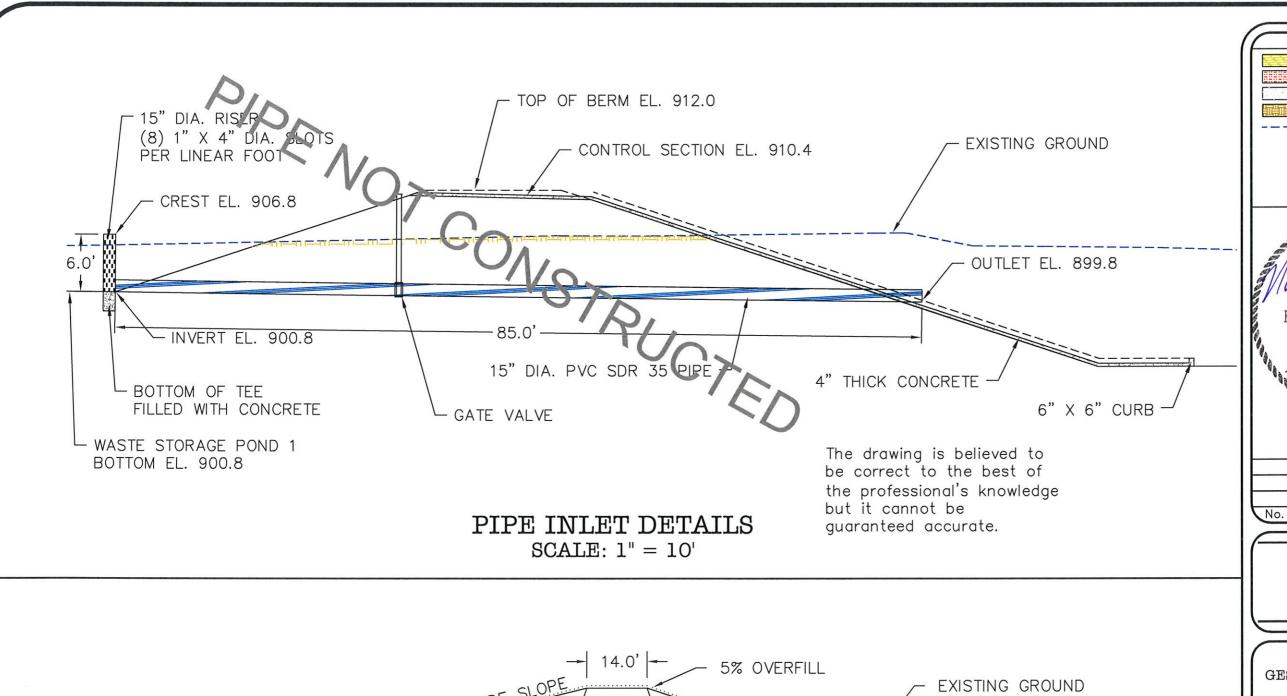

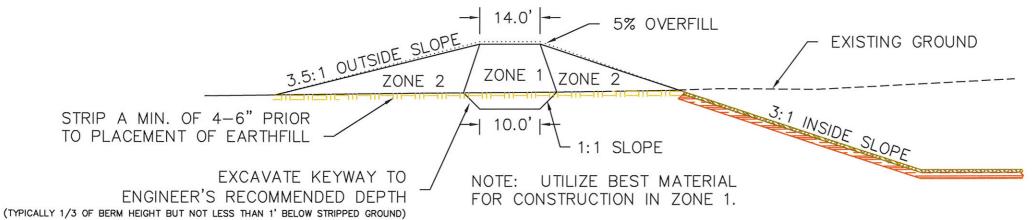

TYPICAL HOLDING POND MAXIMUM BERM DETAIL NOT TO SCALE

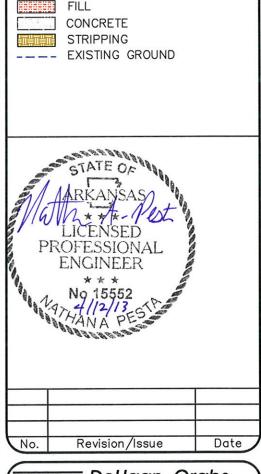

GENERAL NOTES

**GRAVEL** 



DeHaan, Grabs & Associates, LLC Consulting Engineers

Consulting Engineers
PO Box 522, Mandan, ND 58554
(701) 663-1116, FAX: (701) 667-1356
www.dgaengineering.com

C & H HOG FARMS
GESTATION-FARROWING FARM


SECTION 26, T 15 N, R 20 W NEWTON COUNTY, AR

POND INLET & MAXIMUM BERM DETAILS


SHEET:
17

The drawing is believed to be correct to the best of the professional's knowledge but it cannot be guaranteed accurate.

Waste Storage Pond 1 Stage Storage Table									
Elevation	Stage	Area	Volume		Cum. Volume				
(ft)	(ft)	(ft <sup>2</sup> )	(ft <sup>3</sup> )	(ft <sup>3</sup> )	(acre-feet)				
912.0	10.7	20,153	28,793	118,918	THE PERSON NAMED IN COLUMN NAM	Тор			
911.0	9.7	17,130	19,227	100,065	2.3	Freeboard			
910.4	9.1	15,838	16,603	90,125	2.1	25 Year-24 Hour Stage/Overflow El			
909.8	8.5	14,915	7,316	80,838	1.9				
909.3	8.0	14,349	6,946	73,522	1.7				
908.8	7.5	13,435	6,585	66,576	1.5				
908.3	7.0	12,905	6,235	59,991	1.4				
907.8	6.5	12,035	5,898	53,756	1.2				
907.3	6.0	11,557	5,570	47,858	1.1	180 Day Stage			
906.8	5.5	10,723	5,253	42,288	1.0				
906.3	5.0	10,289	4,947	37,035	0.9				
905.8	4.5	9,499	4,648	32,088	0.7				
905.3	4.0	9,093	4,360	27,440	0.6				
904.8	3.5	8,347	4,079	23,080	0.5				
904.3	3.0	7,969	3,808	19,001	0.4				
903.8	2.5	7,263	3,524	15,193	0.3				
903.3	2.0	6,833	3,294	11,669	0.3				
902.8	1.5	6,343	3,060	8,375	0.2				
902.3	1.0	5,897	2,837	5,315	0.1				
901.8	0.5	5,451	2,478	2,478	0.1	Sludge El.			
901.3	0.0	0	0	0	0.0	Bottom			

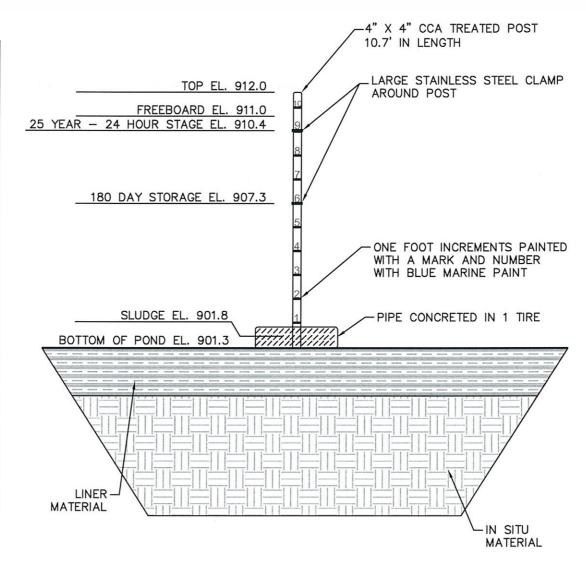

WASTE STORAGE POND 1

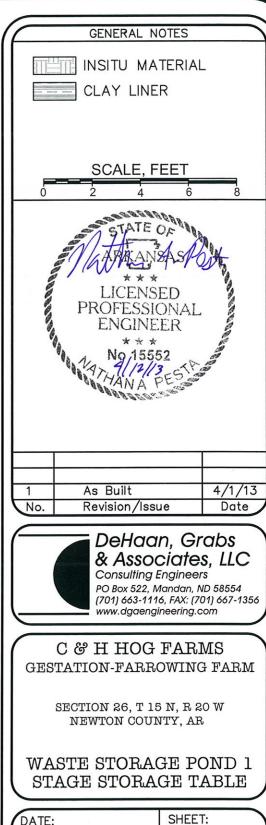

DATE:

MAY 30, 2012

SCALE:

1" = 4'

DRAWN BY:

CAS

CHECKED BY:
DLD

 From:
 Hogan, Stephen

 To:
 Deardoff, Amy

 Subject:
 FW: 2-2

**Date:** Friday, April 12, 2013 10:58:09 AM

**Attachments:** 20130412101532.pdf

Amy,

Please add this to zylab and the web. Permit No. ARG590001.

Thanks,

Stephen

From: Nathan Pesta [mailto:Nathanpdga@btinet.net]

Sent: Friday, April 12, 2013 10:29 AM

To: Hogan, Stephen

Cc: 'Jason Henson'; 'Richard Gray'; 'Patrick Pollack'

Subject: 2-2

Nathan A.Pesta P.E. Senior Project Engineer DeHaan, Grabs and Associates, LLC Bus 701-663-1116 Cell 701-400-3950 Fax 701-667-1356 www.dgaengineering.com